

## **ADDENDUM #3**

April 16, 2024

Miami Palmetto Senior High School New Walkway Canopies & Electrical Routing

> 7460 SW 118<sup>th</sup> Street Miami, Florida 33156 Project # 01516906

Bid Due Date 04/26/2024 @ 4:30 PM SEALED BID

Delivered to MDCPS 1450 NE 2nd Ave, SBAB Room 314 Miami, Florida 33132

TO: All PROSPECTIVE BIDDERS:

The following changes, additions, clarifications, and/or deletions amend the above-captioned Bid and shall become an integral part of the Bid submitted. All other items and conditions shall remain unchanged. Receipt of this Addendum #3 shall be acknowledged in the space provided on the Bid Form.

## **Documents**

- Updated Sheet E-5.0 (Revision #1) (Same as Addendum #02)
- RFI Responses 1 thru 9

Miami Palmetto SHS 7460 SW 118th Street Miami, FL 33156







| RFI's       |   |         |  |           |  |  |  |
|-------------|---|---------|--|-----------|--|--|--|
| ADDENDUM #3 |   |         |  |           |  |  |  |
| RFI No.     | Question  | Date    | Response   | Date      |  |  |  |
| 1           | Please confirm all intrusion detection equipment, wiring, programming, and certification by MDCPS.  | 3/27/24 | Please refer to LV Matrix on sheet E-0.1. All intrusion Detection equipment wiring, and programming to be by GC/EC.  | 4/15/2024 |  |  |  |
| 2           | Please confirm all Clock & Intercom equipment, wiring, programming, and certification by MDCPS.   | 3/27/24 | Please refer to LV Matrix on sheet E-0.1. All Clock & Intercom wiring to be by GC/EC.  | 4/15/2024 |  |  |  |
| 3           | Please confirm all Data/Telephone equipment, wiring, programming, and certification by MDCPS.   | 3/27/24 | Please refer to LV Matrix on sheet E-0.1. All Data/Telecom cabling and equipment is to be by MDCPS.  | 4/15/2024 |  |  |  |
|             | Plans E-2.3 show 3/4" empty conduit w/ pull string for Intercom/clock speaker, Intrusion detection, and data/telephone in classrooms. The number of classrooms nor location provided on plans, please confirm these are all existing conduits and not part of scope | 3/27/24 | The typical conduit runs in the existing classrooms are existing and diagrammatical, they are not part of the scope of work.   | 4/15/2024 |  |  |  |
| 5           | On revised Sheet E-5.0, Note 6 should say (4) 600, (1) 3/0 GROUND IN (6) 4" C. Please can the engineer revise this?   | 3/27/24 | Please see revised sheet E-5.0 Feeders has been updated.   | 4/15/2024 |  |  |  |
| 6           | Panel DP-7 (1200A) have a similar feeder as Panel MAIN MC CENTER (2500A). Both have a feeder of (4) 600, (1) 3/0 GROUND IN (3) 4" C, but Panel MAIN MC CENTER have twice the Amps. Please, can the engineer confirm this?   | 3/27/24 | Please see revised sheet E-5.0 MC Panel size has been updated.   | 4/15/2024 |  |  |  |
| 7           | Please clarify Scope, the drawings do not show devices and there is no underground intended for fire alarm system. (No Fire Alarm Works?)   | 3/27/24 | There are no new FA devices being provided as part of the scope of work, if during construction an existing device is removed, that device will need to be replaced.   | 4/15/2024 |  |  |  |
| 8           | Sheet E-2.3 Shows Diagram of ITV, Intercom and Intrusion Systems, but they do not show devices on the plans, please clarify the scope.  | 3/27/24 | There are no new ITV, Intercom, or Intrusion Detection devices being provided as part of the scope of work, if during construction an existing device is removed, that device will need to be replaced. Riser is dagrammatical of the infrastructure required for that system. |           |  |  |  |
| 9           | Low Voltage Underground, only for Data Systems?   | 3/27/24 | All Low Voltage systems to be run underground as indicated in the LV Riser Diagram.  | 4/15/2024 |  |  |  |

This item has been digitally signed and sealed by Hammond & Associates, Inc. on the date adjacent to the seal.


Printed copies of this document are not considered signed and sealed and the signature must be verified on any electronic copies.

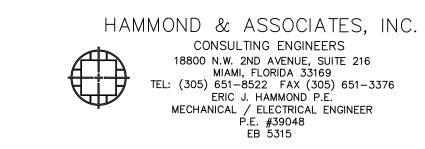

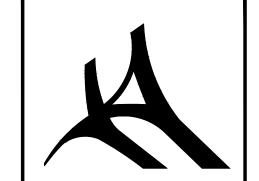

M. Hajjar & Associates Inc.

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ERIC HAMMOND, PE PE 39048

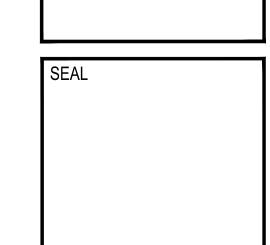MIAMI-DADE COUNTY PUBLIC SCHOOL
MIAMI PALMETTO SHS
7460 SW 118 TH STREET, MIAMI, FL 33156

| NO.                | REVISION | DATE     |  |  |
|--------------------|----------|----------|--|--|
| 1 BCC COMMENTS     |          | 11/02/23 |  |  |
|                    |          |          |  |  |
|                    |          |          |  |  |
|                    |          |          |  |  |
|                    |          |          |  |  |
| PROJECT            |          |          |  |  |
| MIAMI PALMETTO SHS |          |          |  |  |
|                    |          |          |  |  |

DATE June 09, 2022

DRAWING ELECTRICAL POWER RISER DIAGRAM

SCALE AS SHOWN


DRAWN H.A.

REVIEWED E.H. PROJ. NO.

01516906 SHEET NO

SHEET NO.

E-5.0

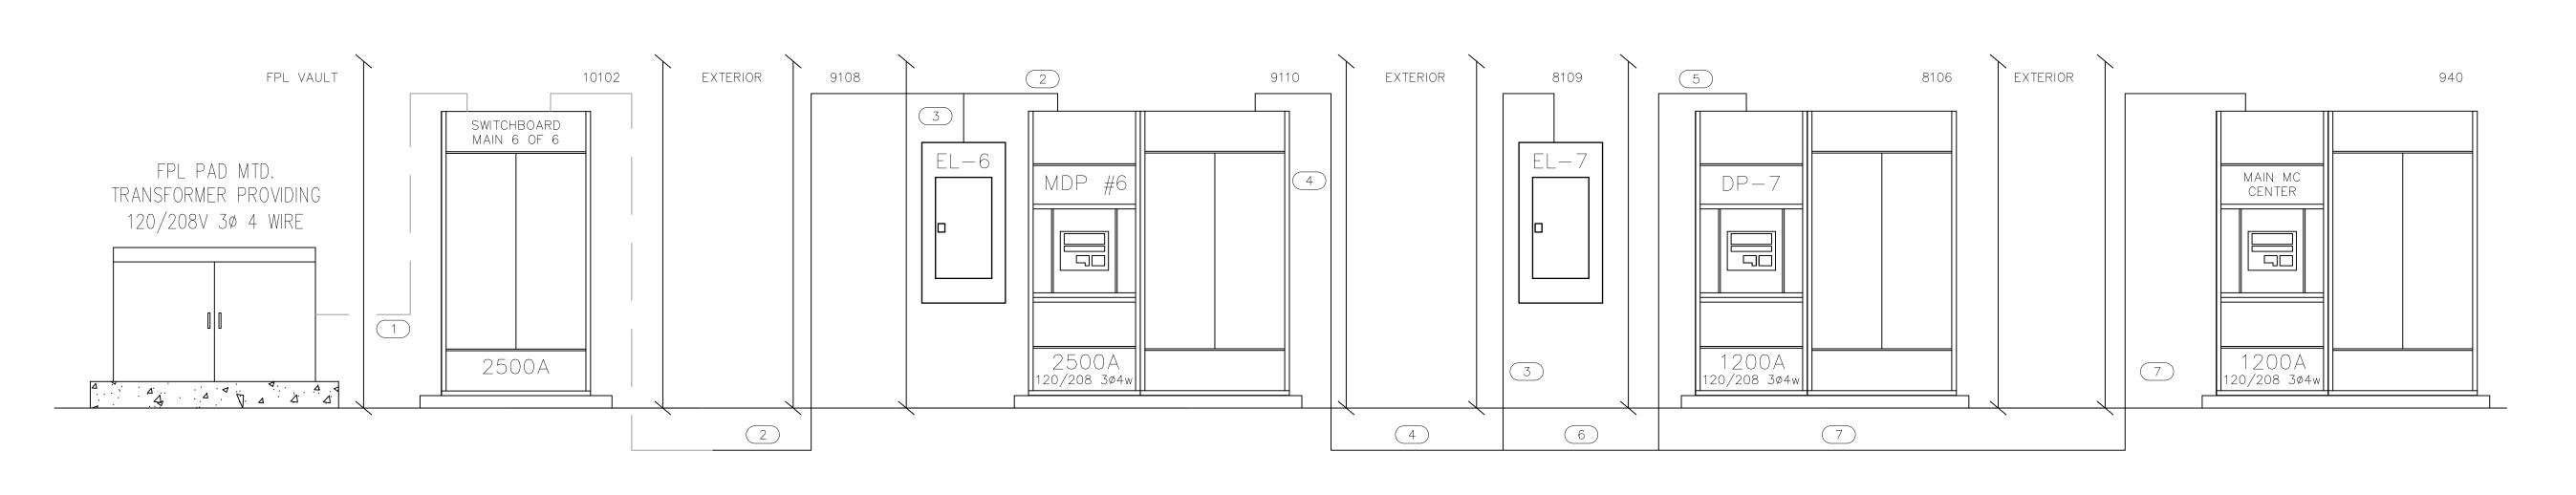



SCALE: 3/32"= 1'-0"



ALL PANELS AND SWITCHBOARDS
ARE EXISTING TO REMAIN

DRAWING KEY NOTES

1 EXISTING CONDUITS

2 (4) 600, (1)#3/0 GROUND IN (6) 4" C.

3 (4) 3/0, (1) 6 GROUND IN (1) 2" C. 4 (4) 3/0, (1) 6 GROUND IN (1) 2" C. AND (4) 600, (1) 3/0 GROUND IN (6) 4" CONDUIT. 5 (4) 600, (1) 3/0 GROUND IN (3) 4" C. 6 (4) 600, (1) 3/0 GROUND IN (6) 4" CONDUIT.

7 (4) 600, (1) 3/0 GROUND IN (3) 4" CONDUIT.